

ATLAS LOCATION

BUILDING COVERAGE:

Percent Coverage Calculation

Lot Area: 23782.1 Sq.Ft.

Existing Area:

Existing Dwelling

Existing Front Porch Proposed Area:

Proposed Outdoor Kitchen = 65.3 Sq.Ft.Proposed Roof Over = 384.0 Sq.Ft.Proposed Fire Structure = 14.0 Sq.Ft.

= 4000.0 Sq.Ft.

= 117.0 Sq.Ft.

= 239.4 Sq. Ft.

Min 6' Depth

Underlying sand & gravel strata

DRAINAGE CALCULATIONS SYSTEM A:

Runoff = $2612.4 \text{ s.f.} \times 3^{\circ}/12 = 653.1 \text{ cu.f.}$

Proposed Pool & Spa = 860.0 s.f. Runoff = 860.0 s.f. $\times 3^{\circ}/12 = 215.0$ cu.f.

Runoff = $580.0 \text{ s.f.} \times 3^{\circ}/12 = 145.0 \text{ cu.f.}$

Use 8 galleys 4.5' deep, 4' eff. depth = 32.0'

1013.1 cu.ft./ 34.0 cu.f. per ft. of 4'x8.5' Leaching Galley

Proposed Sports Court = 580.0 s.f.

Proposed Patio = 2612.4 s.f.

= 29.8 ft. reg'd.

LEACHING GALLEY DETAIL

Total Coverage: 4580.3 Sq.Ft.

Percent Coverage = \times 100% = % Coverage

Percent Coverage = \times 100% = % Coverage

Percent Coverage = 19.3% > 15.0% M.C.

IMPERMEABLE LOT COVERAGE:

Existing Lot Coverage Calculation

Lot Area: 23782.10 Sq. Ft. Existing Area:

Existing Concrete Utility Pad

Existing Dwelling 4000.0 Sq. Ft. Existing Driveway 3100.0 Sq. Ft. Existing Patio = 650.0 Sq. Ft. Existing Walkway = 475.0 Sq. Ft.

Total Coverage: 8464.4 Sq. Ft. > 7467.50 Sq. Ft.

Proposed Lot Coverage Calculation

Lot Area: 23782.10 Sq. Ft.

Existing Area:


Existing Dwelling = 4000.0 Sq. Ft. Existing Walkway = 475.0 Sq. Ft. = 239.4 Sq. Ft. Existing Concrete Utility Pad Proposed Area:

Proposed Pool 800.0 Sq. Ft. Proposed Spa 100.0 Sq. Ft. Proposed Outdoor Kitchen 65.3 Sq. Ft. Proposed Pool Equipment = 13.5 Sq. Ft. Proposed Fire Structure = 14.0 Sq. Ft. Proposed Roof Over = 384.0 Sq. Ft.

Total Coverage: 6091.2 Sq. Ft. < 7467.50 Sq. Ft.

ZONING	REQUIRED	EXISTING	PROPOSED
Area	14500 SQ. FT.	23782.1 SQ. FT.	23782.1 SQ. FT.
Front Yard	35'	50.7'	50.7'
Side Yard	15'	9.8'	9.8'
Rear Yard	25'	121.7'	121.7'
Street Frontage	100'	100.1'	100.1'
Max. Building Coverage	15%	17.3%	19.3%
Max. Permitted Impervious Coverage	7467.5 SQ. FT.	8464.4 SQ. FT.	6091.2 SQ. FT.

ZONED: Residence District B

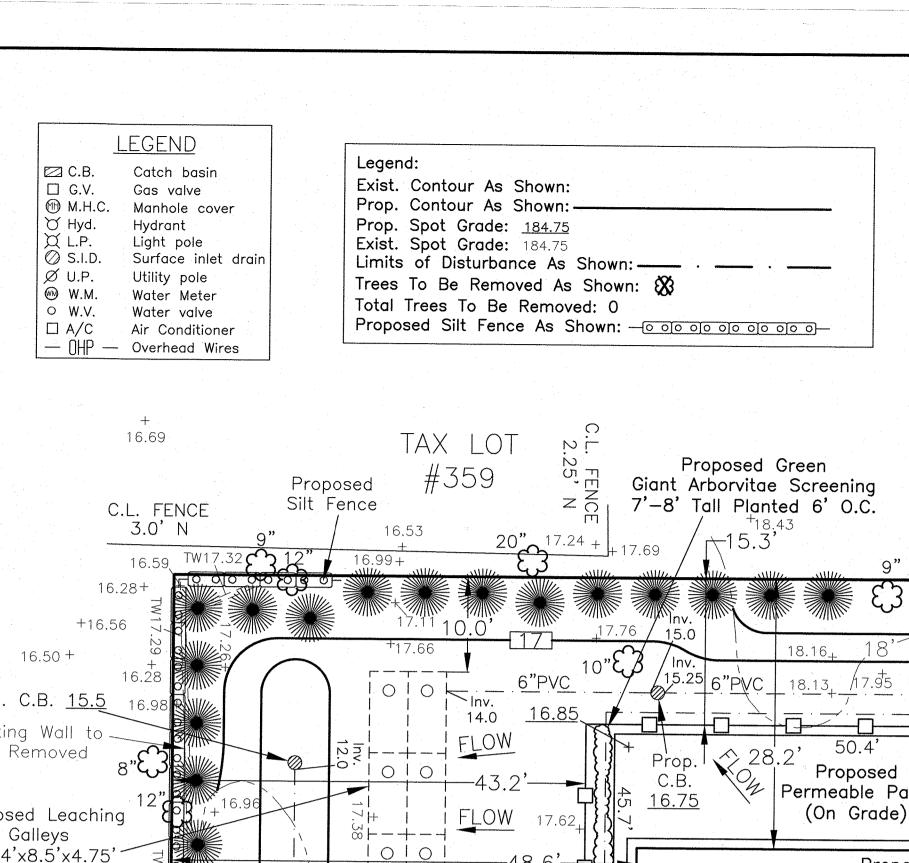

Note: Doors leading into pool enclosure area to have door alarms—R326.4.2.8 Note: All water either overflowing or emptying from the pool shall be disposed of on the owners property.

Note: All lights used to luminate the swimming pool or pool area shall be shielded so as to prevent the shining upon the property of any adjacent Note: No Loudspeaker device or equipment of any kind shall be installed or used in or about the swimming pool or pool area unless same shall be muted so as to prevent any noise from being heard beyond the property

lines of the owner's land. Note: Swimming pool shall be equipped with an approved pool alarm device as per the Residential Code of New York State. The alarm shall be capable of detecting a child entering the water and giving an audible alarm when it detects a child entering the water. The alarm shall be classified by Underwriters Lab (or other approved independent testing lab) to reference standard ASTM F2208 and shall produce audible poolside and at another location on the premises where the swimming pool is located. All devices shall be installed, used and maintained in accordance with the manufacturer's specifications.

Note: Suction outlets shall be designed to produce circulation throughout the pool & spa, and shall be protected against user entrapment.


Note: Provide suction fittings as per R326.6.2 Note: Provide atmospheric vacuum relief system as per R326.6.3

Note: Provide dual drain separation as per R326.6.4 Note: Pool cleaner fittings to comply with R326.6.5


Within the property lines of the subject parcel

Note: The proposed swimming pool shall be surrounded by a temporary barrier during installation or construction and shall remain in place until a permanent barrier in compliance with R326.5.2 of the NYS Supplement Note: The proposed swimming pool shall be surrounded by a permanent barrier

Once construction is complete in compliance with R326.5.3 of the NYS Supplement Note: All pool barrier gates shall comply with Village of Woodsburgh Building Codes And New York State Building Codes Note: All existing and proposed fencing to be located or relocated, to be on or

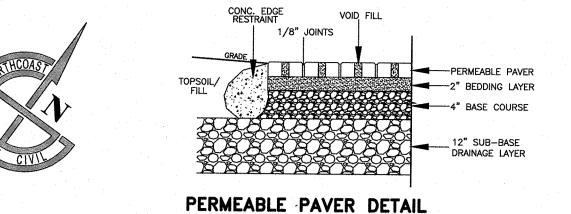

NOTES:
SUB-BASE: OPEN-GRADED AGGREGATE COMPRISED OF 2" TO 3" FRACTURED ROCK.
BASE: OPEN-GRADED AGGREGATE COMPRISED OF SMALL TO MEDIUM SIZED BEDDING COURSE: OPEN-GRADED AGGREGATE BENETH UNIT PAVERS COMPRISED OF SMALL STONE CHIPS (1/4" TO 3/8").

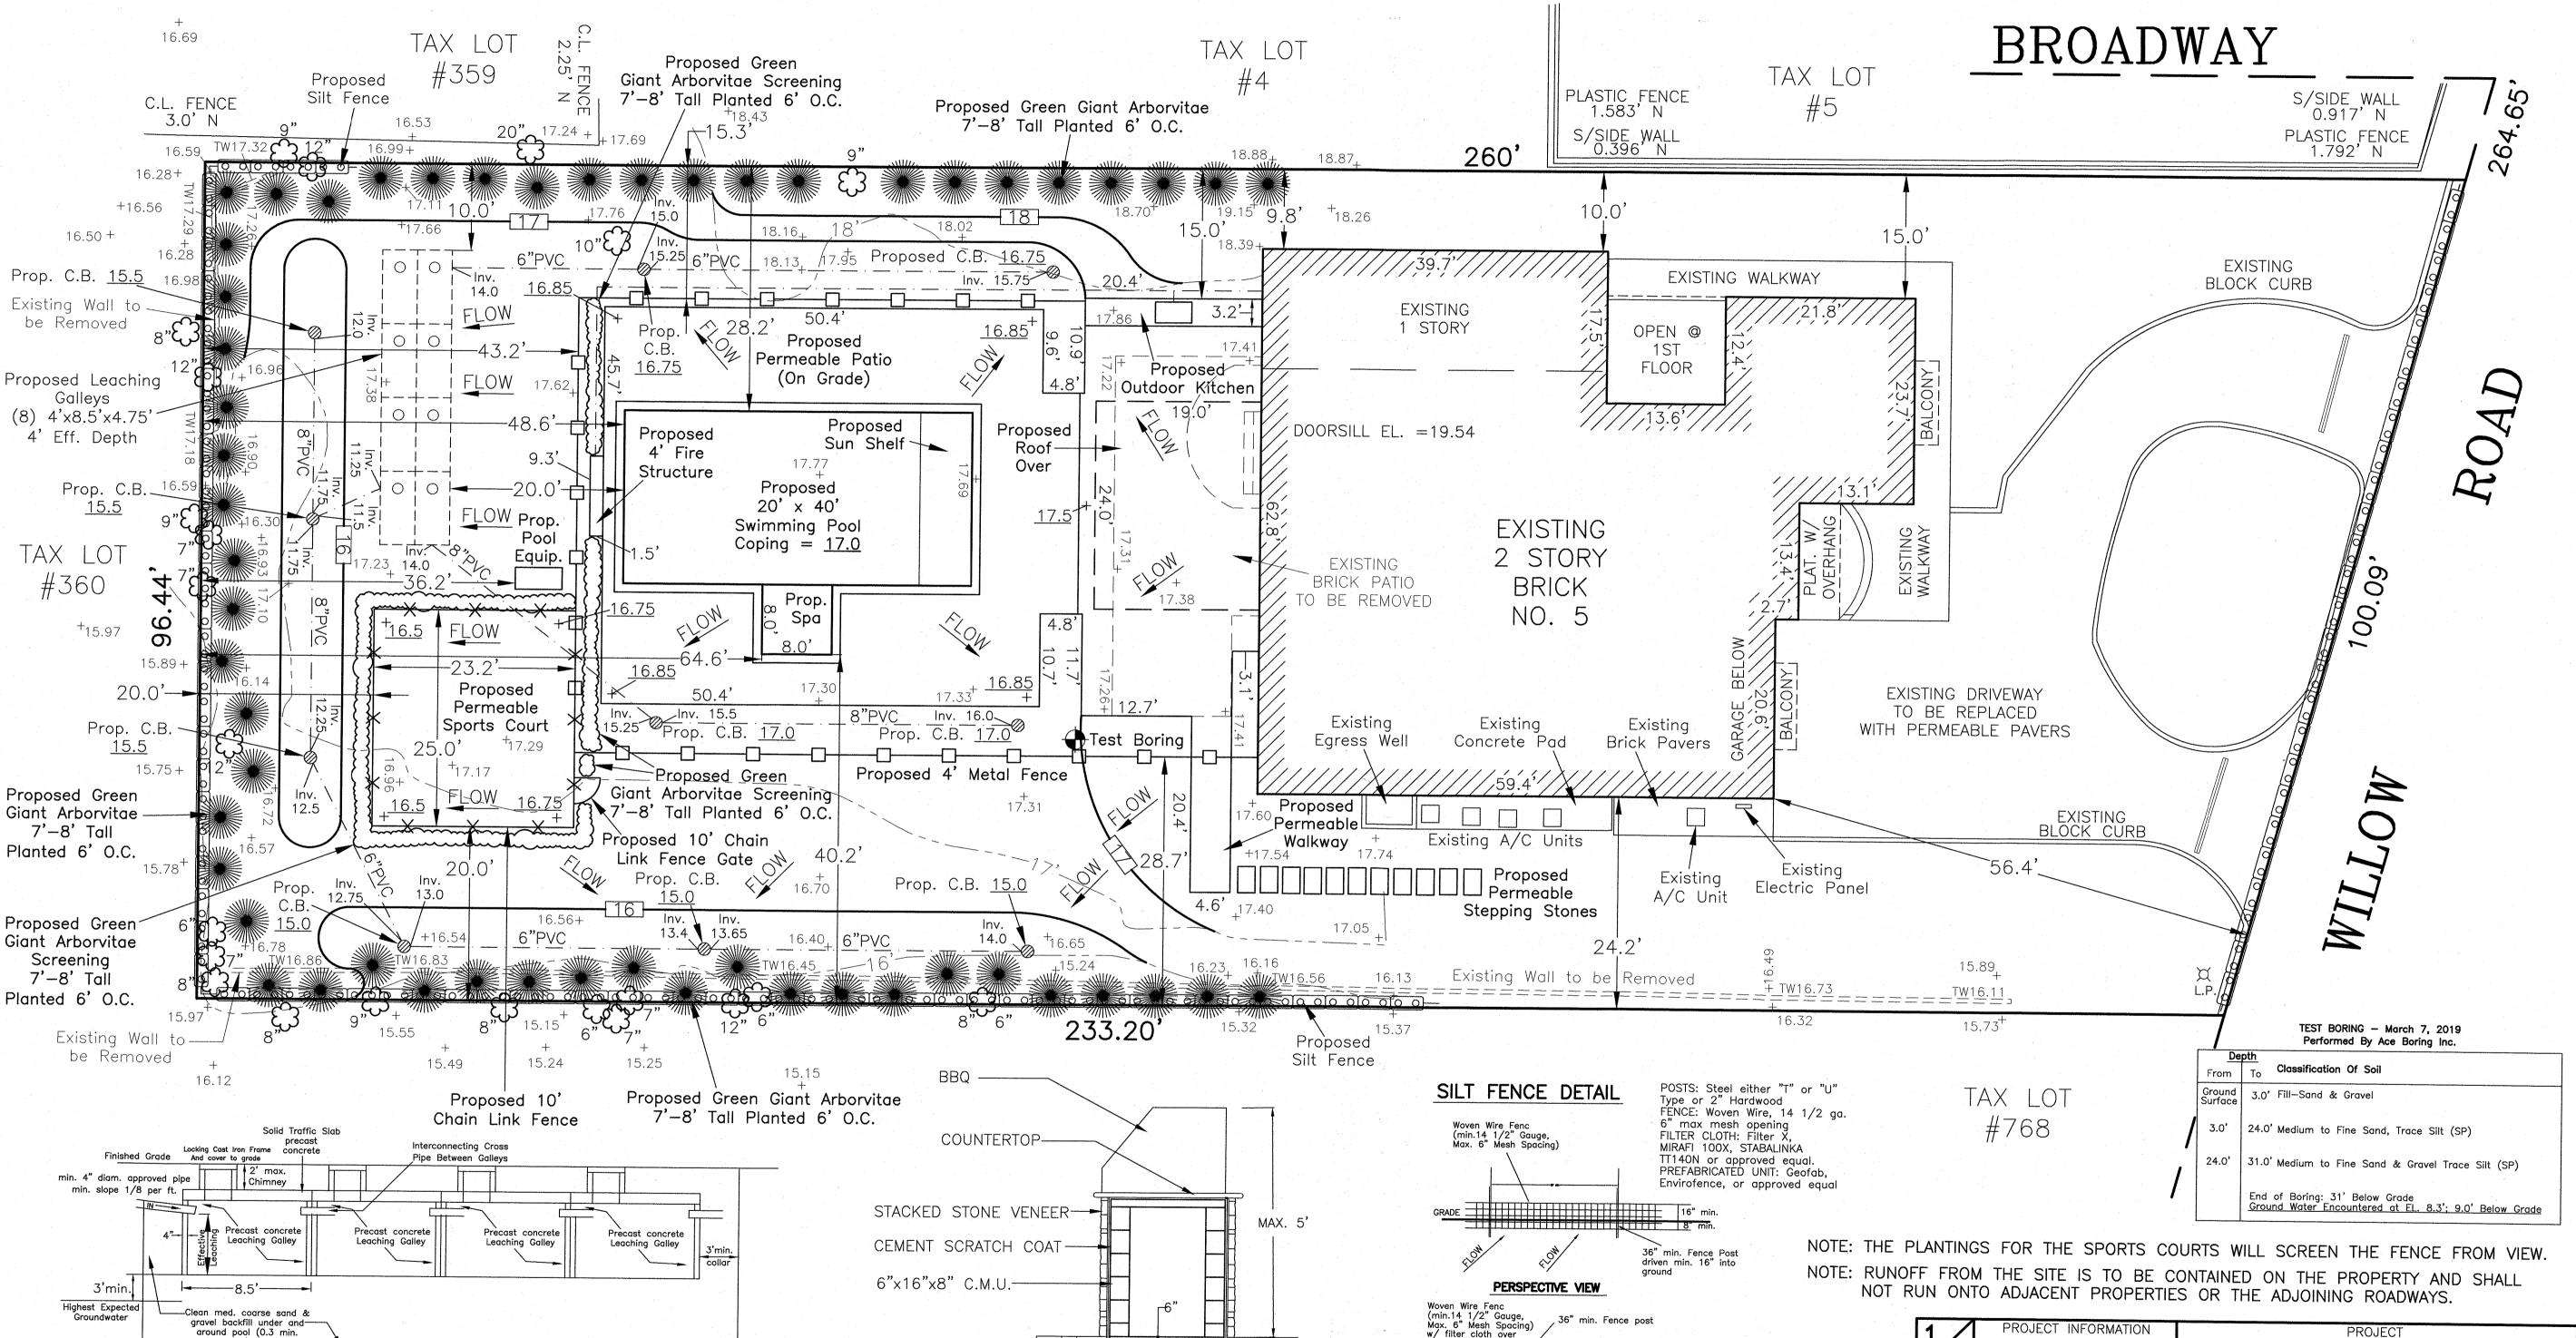

2. Filter cloth to be fastened securely to woven wire fence with ties spaced every 24" at top and SUBBASE 4'-0" 3. When two sections of filter cloth adjoin each other they shall be overlapped by 6" and folded. 4. Maintenance shall be performed as needed and material removed when "bulges" develop in silt fence. OUTDOOR KITCHEN DETAIL GRAPHIC SCALE

(IN FEET)

SCALE: 1" = 10'

min. 6" into ground SECTION

fence posts with wire ties or staples.

1. Woven wire fence to be fastened securely to

6"POURED CONC.

1.4 X 1.4 WWM

Filter Fabric Installed

Grade or Paving

Cast Iron Frame -

24"

CATCH BASIN DETAIL

(NOT TO SCALE)

SLAB W/6 X 6-W

COMPACTED

0.55 ACRI 23782.10 SQ. MUTAC REVISED: 4/20/2022 REVISED: 1/20/2022

REVISED: 11/17/2021

REVISED: 8/24/2021

REVISED: 8/10/2021

REVISED: 7/28/2021

REVISED: 4/16/2021

DRAWN BY:

SCALE:

HECKED BY

3/15/202

1"=10

NAVD'88 NCTM:

SITUATED:

INCORPORATED VILLAGE OF WOODSBURG Northcoast


PROJECT


SITE PLAN

OF PROPERTY

ENGINEERING 23 SPRING STREET **OYSTER BAY, NY 11771** P:(516)922-3031 | F:(516)922-7475

& CIVIL

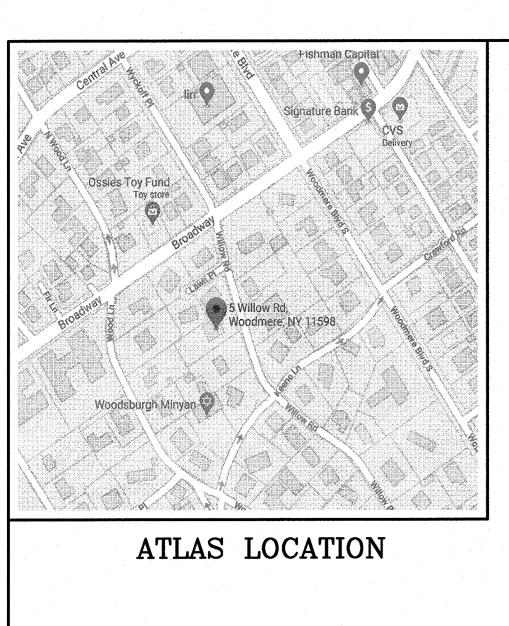

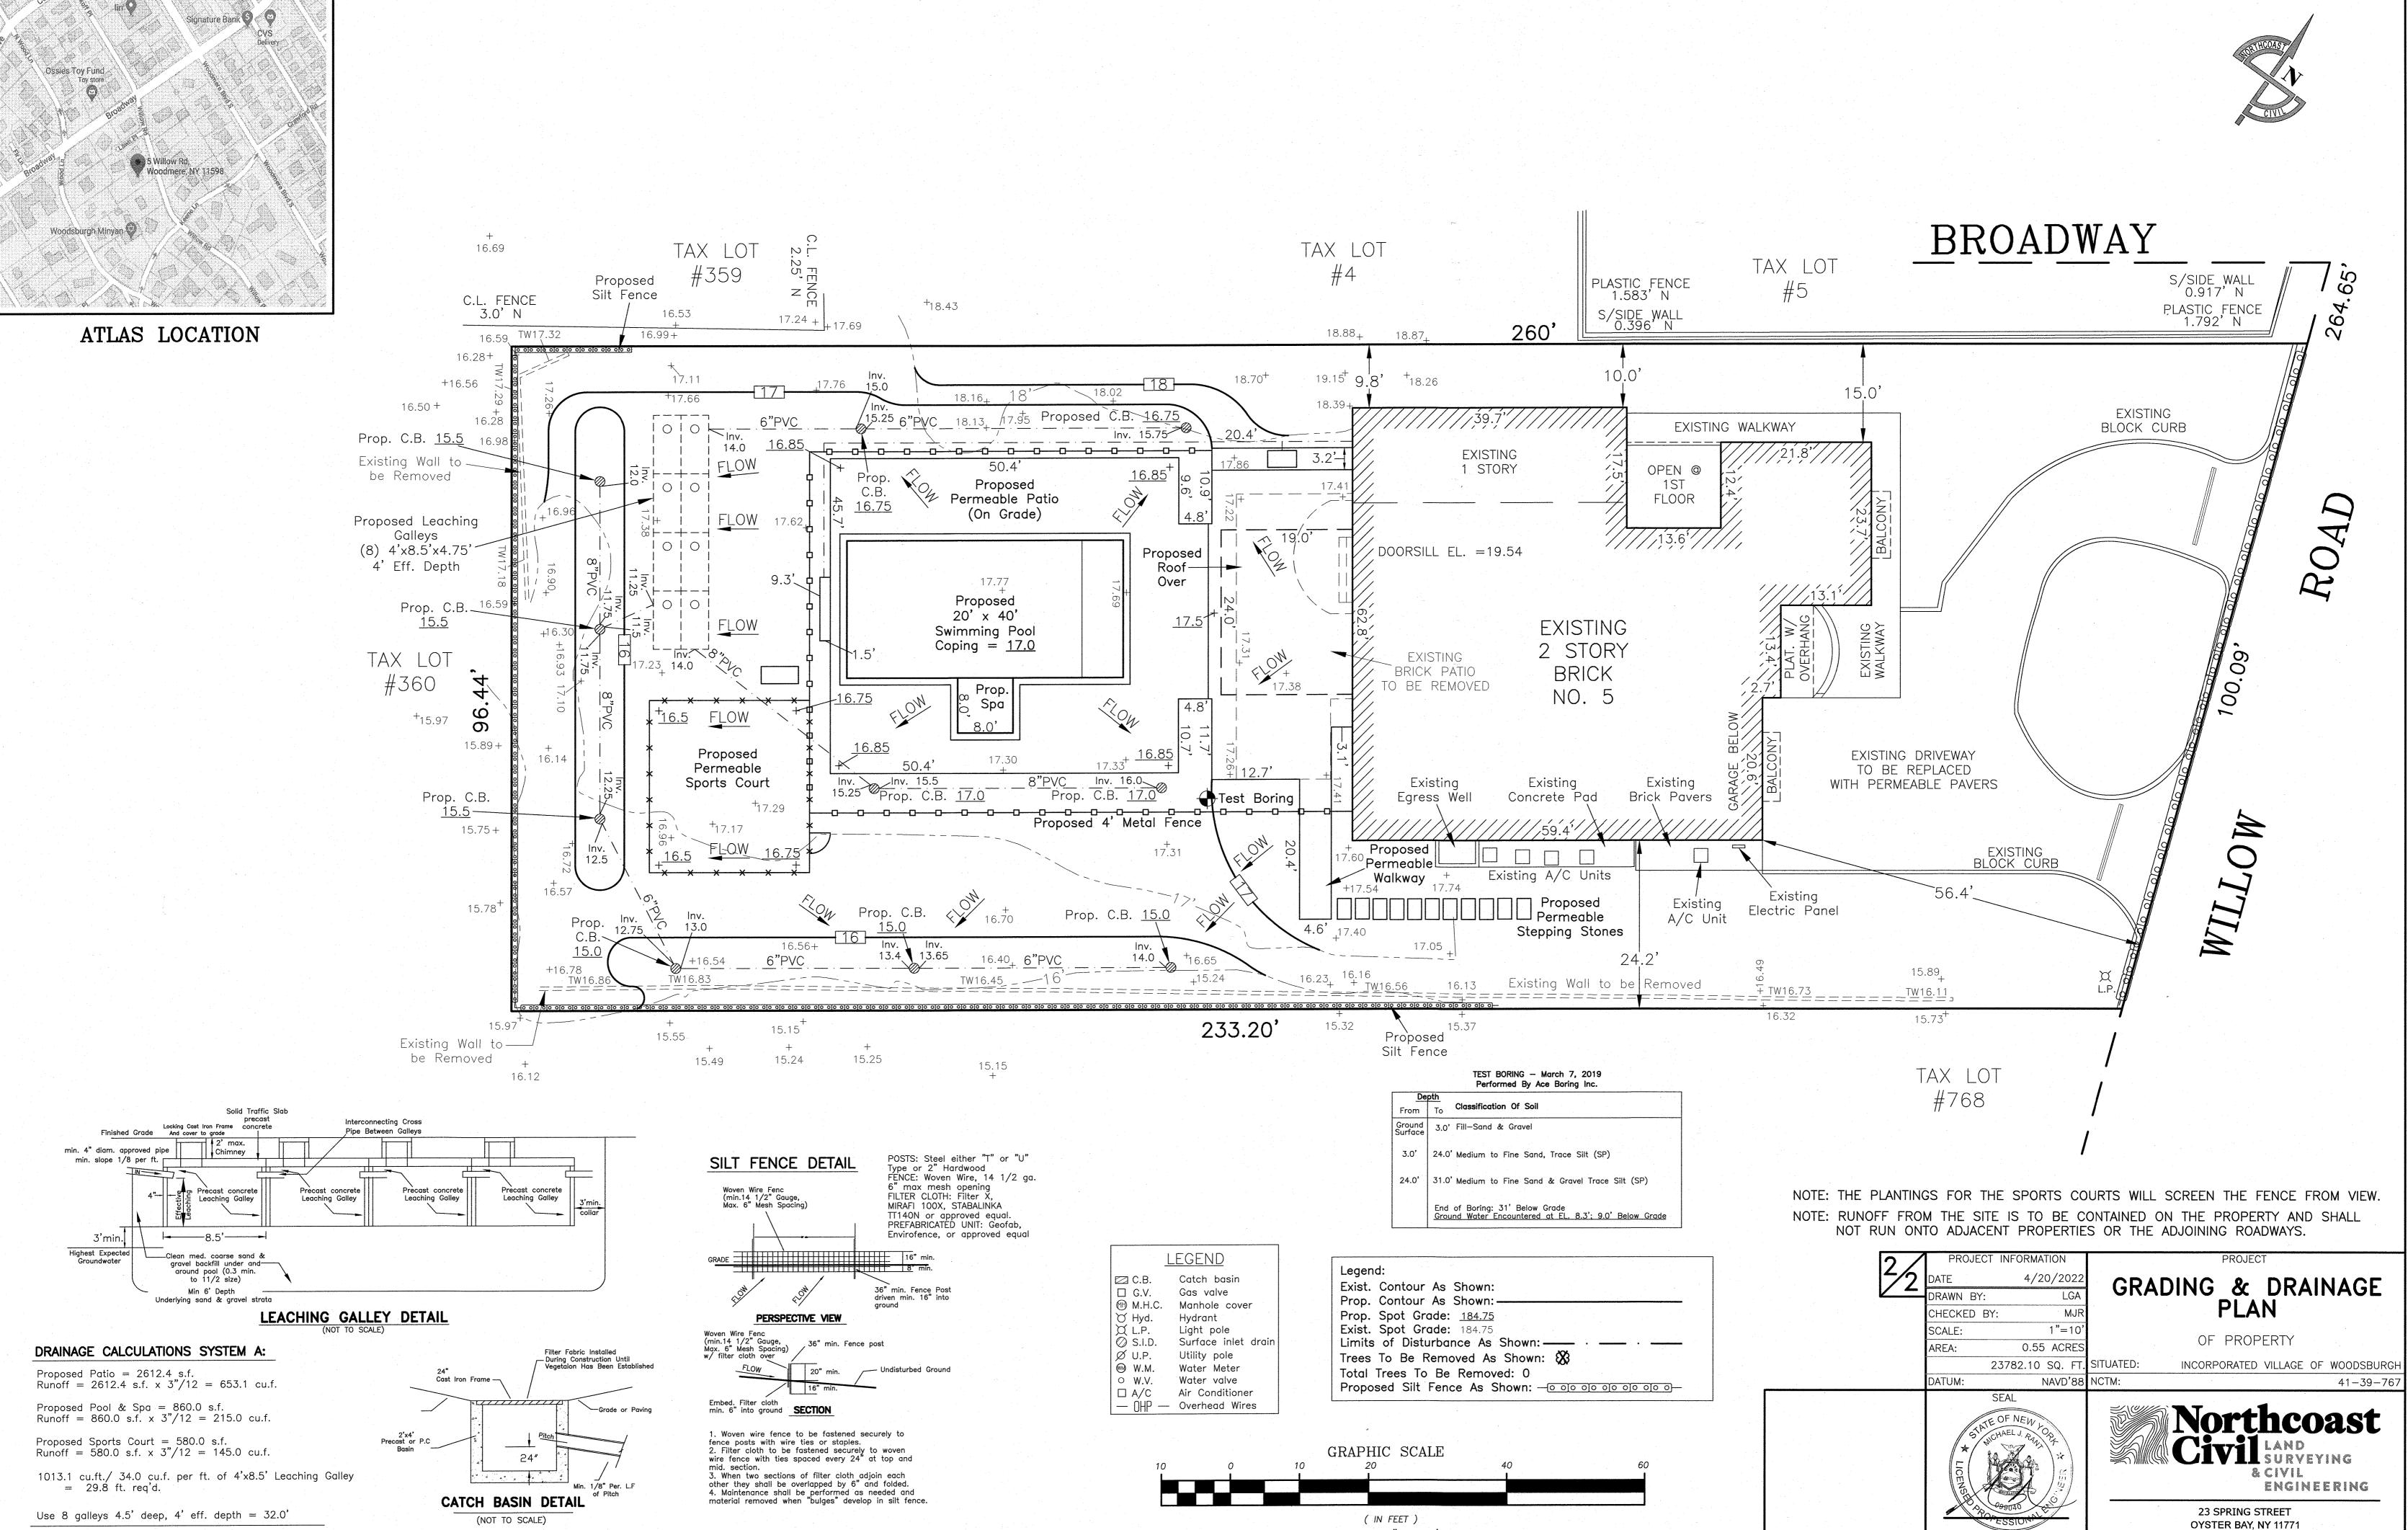

SCALE: 1" = 10'

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